


## MECHANICAL ROOM #213

**FINAL SPRINKLER LAYOUT INCLUDING HEADS BELOW DUCTS & OBSTRUCTIONS >48" WILL BE UPDATED AFTER COORDINATION - PROVIDED AS "AS-BUILT" MODIFICATION**

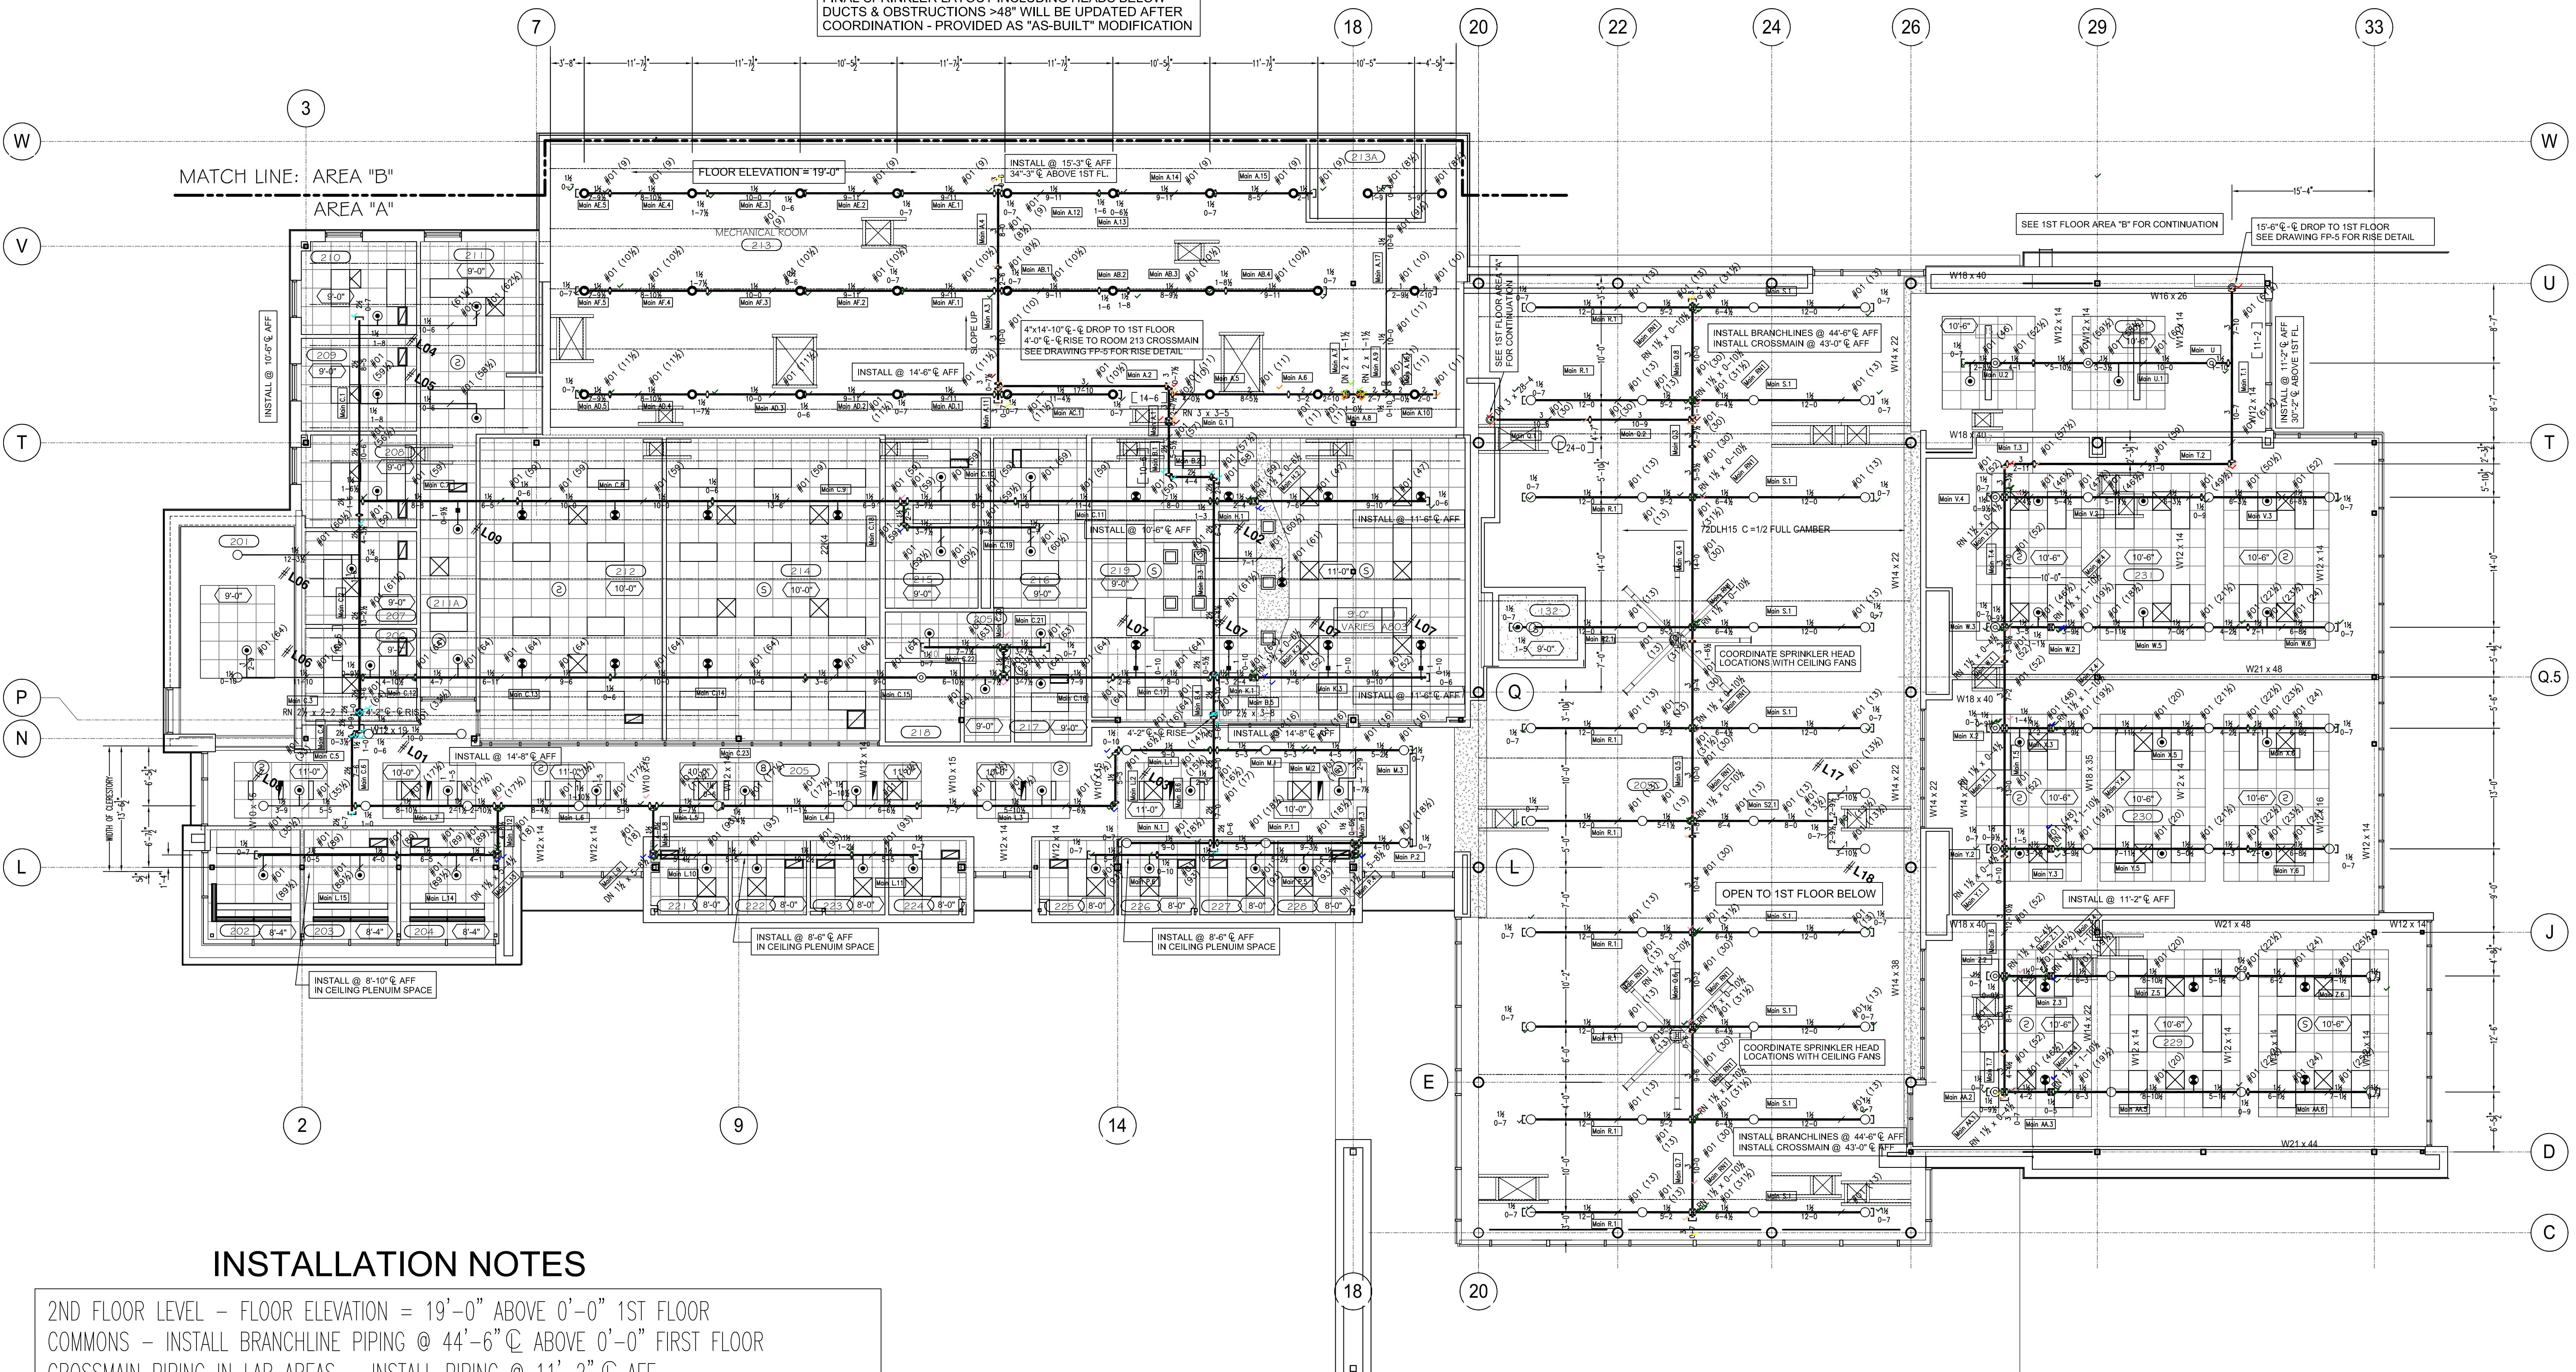

# INSTALLATION NOTES

2ND FLOOR LEVEL - FLOOR ELEVATION = 19'-0" ABOVE 0'-0" 1ST FLOOR  
COMMONS - INSTALL BRANCHLINE PIPING @ 44'-6" C ABOVE 0'-0" FIRST FLOOR  
CROSSMAIN PIPING IN LAB AREAS - INSTALL PIPING @ 11'-2" C AFF  
OFFICE AREAS - INSTALL PIPING @ 10'-6" C AFF (RISE WHERE INDICATED)  
OFFICE AREAS - INSTALL SPRIGS FOR UPRIGHT SPRINKLER HEADS WHERE SHOWN  
CROSSMAIN PIPING IN MECHANICAL RM 213 - INSTALL PIPING @ 14'-6" C AFF - SLOPE U

WEST CIPHERSTORY ARFA

BEAM ELEVATIONS VARY THIS AREA FROM 10" TO 14" - OBSTRUCTED CONST  
UPRIGHT SPRINKLER HEADS TO BE LOCATED 1"-6" MAX. BELOW BEAM  
BRANCHLINE PIPING ELEVATIONS ELIMINATE THE NEED FOR SPRIGS

2ND FLOOR - 16,827 SQ.FT.

SCALE: 1/8" = 1'-0"

NO.	REVISIONS	BY	DATE		SYM.	QTY.	SPRINKLERS			DESCRIPTION	
2	UPDATES PER MIRON CONSTRUCTION REVIEW	RPK	2/7/19		●	28	SIN #	K-FAC	TEMP	TYCO TY-FRB 5.6K QR SC BRASS UPRIGHT	
					○ ⊙	84	TY313	5.6	200°	TYCO TY-FRB 5.6K QR SC BRASS UPRIGHT	
					●	52	TY3531	5.6	155°	TYCO TY-FRB 5.6K QR SC CONCEALED WHITE PENDENT	
					✖	23	TY5522	11.2	155°	TYCO ELOC 11.2K QR EC CONCEALED WHITE PENDENT	
					AHJ: GREEN BAY		TOTAL # SPRINKLERS ON PROJECT = 623			TOTAL SYSTEMS ON PROJECT = (2)	(1) WET & (1) DRY SYST PER NFPA #13 - 2013 ED

NICET Level IV Automatic Sprinkler  
System Layout Certification #79  
Richard P. Kossler

*FIRELINE*

*SPRINKLER CORPO*

**TITLE**

# BROWN COUNTY STEM INNOVATION CENTER GREEN BAY, WISCONSIN

SHEET/DRAWING No.

FP-4 OF 5

PROJECT 11670-18	REV. —
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